



NOTE:  
 1. STATIONING OF PIERS IS GIVEN AT THE MIDPOINT UNLESS NOTED OTHERWISE.  
 2. SEE RETAINING WALL SPECIFICATIONS FOR SURFACE TREATMENT

Legend:  
 TR Top of Rail Elevation  
 TW Top of Wall Elevation  
 TL Top of Ledge Elevation  
 [Symbol] Scupper, Typ.

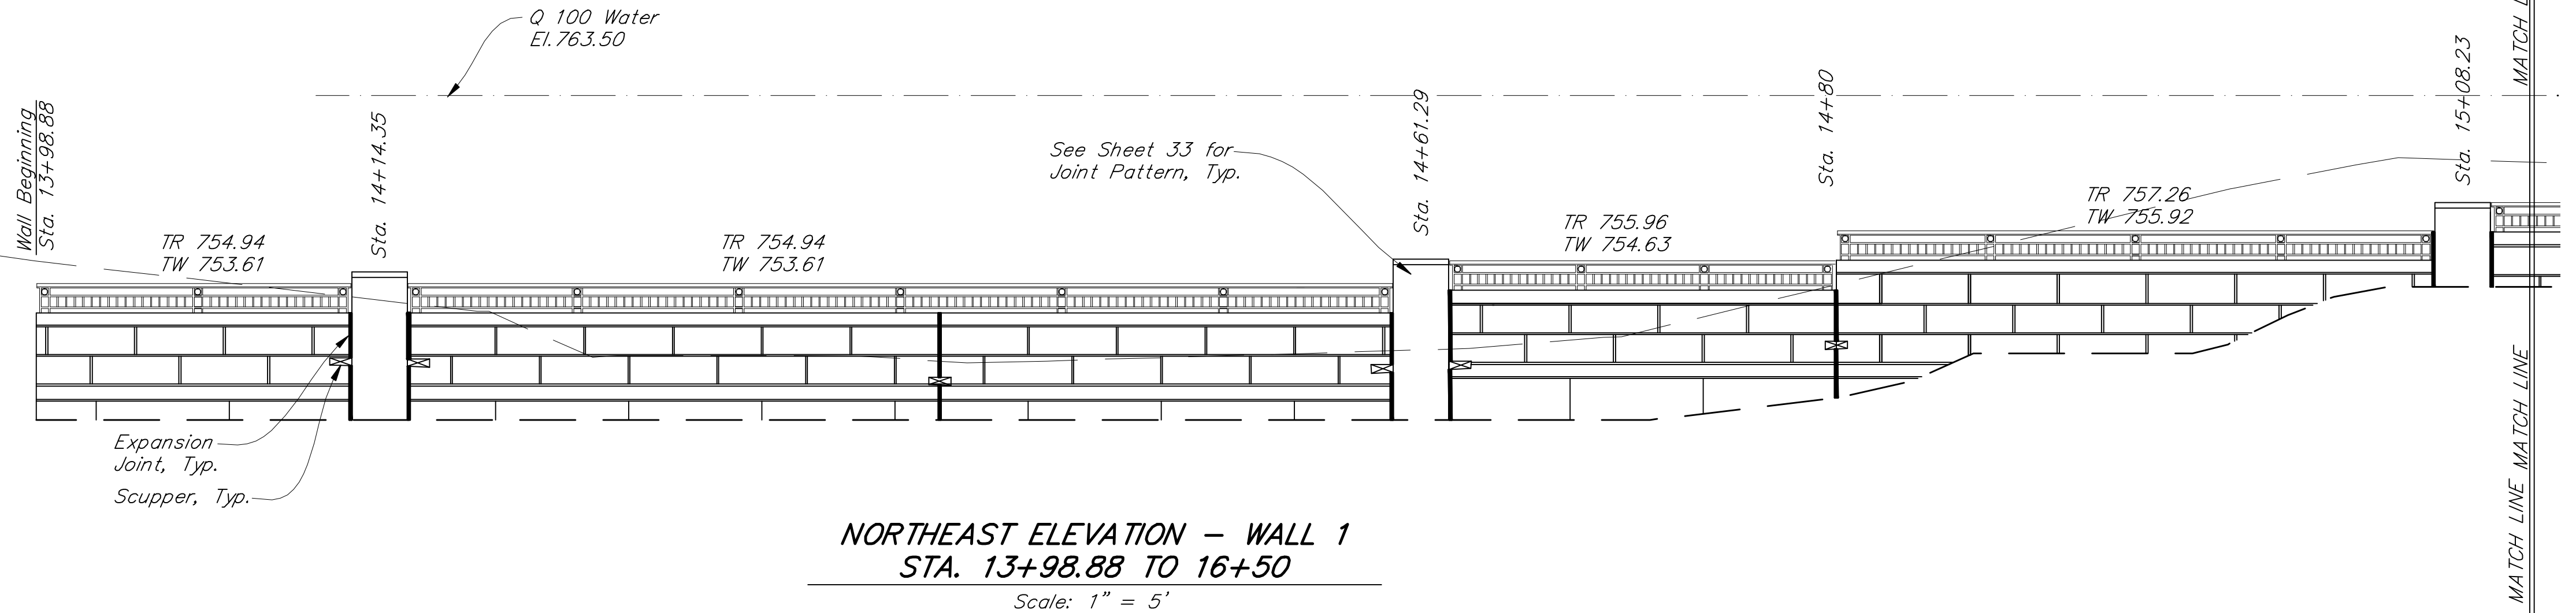

**NORTHEAST ELEVATION - WALL 1**  
**STA. 13+98.88 TO 16+50**  
 Scale: 1" = 5'

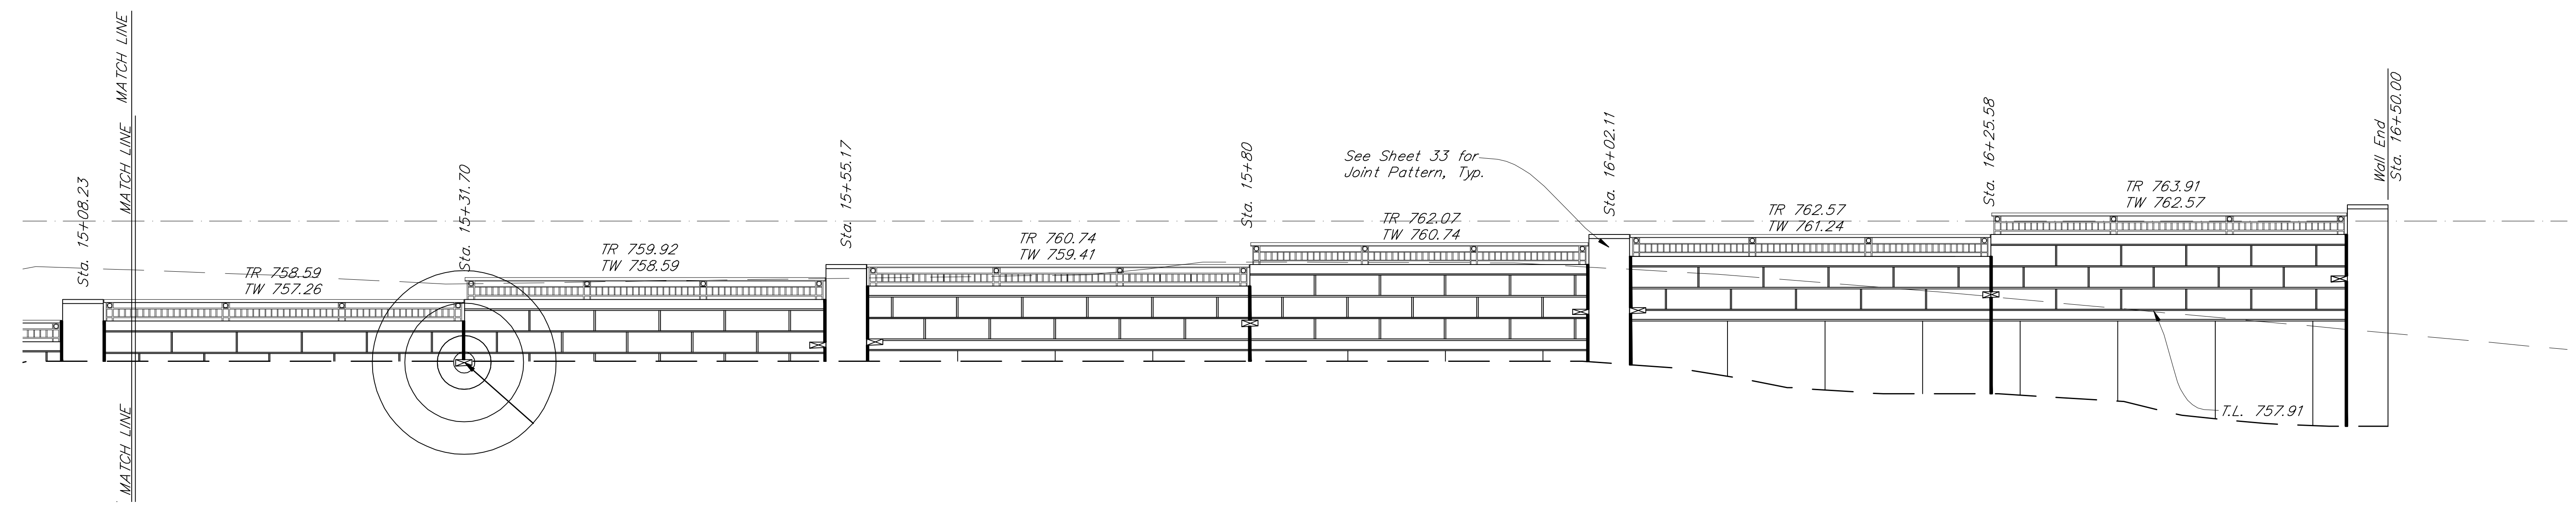

I:\50631\Development\Drawings\Drawings\5063\_271.dwg Keith Cruz Plot:9/30/2011 8:37 AM Save:9/30/2011 8:01 AM

**BFS**  
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RECOMMENDED FOR APPROVAL:		
DESIGN ENGINEER	DATE	
DESIGNED: SMD	DRAWN: SMD	
CHECKED: JGG	CHECKED: JGG	

INDIANA  
 DEPARTMENT OF TRANSPORTATION

RETAINING WALL DETAILS  
 NOBLESVILLE RIVERWALK

HORIZONTAL SCALE 1" = 5'	BRIDGE FILE
VERTICAL SCALE 1" = 1'	DESIGNATION
SURVEY BOOK 347	SHEET 29 OF 47
CONTRACT	PROJECT

BFS NO. 5063.0501